

ZONING INFORMATION		
ZONE DESIGNATION RU	PERMITTED	PROVIDED
LOT FRONTAGE (m)	60.0	40.0
LOT DEPTH (m)	N/A	107.0
LOT AREA (sq. m)	10,000	4,260

LEGEND

+214.08EX

100.00 X

2%

FF

TFW

TFWR

TFWG

T/S

USF

USFG

WOB

RUSF

DSO

2R

T

110

EXISTING SPOT ELEVATION

PROPOSED SPOT ELEVATION

PROPERTY BOUNDARY

SURFACE DRAINAGE & GRADE

FINISHED FLOOR ELEVATION

TOP OF FOUNDATION WALL

TOP OF FOUNDATION WALL

AT REAR OF THE HOUSE

TOP OF FOUNDATION WALL

GARAGE

TOP OF SLAB

UNDERSIDE OF FOOTING

UNDERSIDE OF FOOTING

GARAGE

WALKOUT BASEMENT

UNDERSIDE OF FOOTING

AT WALKOUT BASEMENT

DOWNSPOUT LOCATION C/W

SPLASH PAD

FIRST FLOOR ENTRYWAY

NO. OF RISERS

LIGHT STANDARD

FIRE HYDRANT

CURB STOP

COMMUNICATION PEDESTAL

TRANSFORMER

PAVED DRIVEWAY

MANHOLE

TREE

MUNICIPAL NUMBER

PROPERTY BAR (SIB)

* REFER TO CITY OF THUNDER BAY
ENGINEERING STANDARDS DRAWING M-110 FOR
ADDITIONAL STANDARD DRAWING SYMBOLS

CITY OF THUNDER BAY
GENERAL NOTES


- ALL DIMENSIONS AND ELEVATIONS ARE IN METERS UNLESS OTHERWISE INDICATED.
- DOWNSPOUTS SHALL BE LOCATED AT THE FRONT OF THE BUILDING AS MUCH AS PRACTICAL AND ALL DOWNSPOUTS SHALL BE DIRECTED TO DRAIN TO THE FRONT OF THE LOT AND SHALL NOT OUTLET DIRECTLY INTO ANY DRAINAGE SWALES. SPLASH PADS TO BE PROVIDED AT ALL ROOF DOWNSPOUT LOCATIONS.
- REAR YARD SLOPES SHALL NOT BE LESS THAN 1.0%.
- THE APPROVAL OF THIS PLAN DOES NOT EXEMPT THE OWNER (OR THEIR CONTRACTOR) TO OBTAIN THE VARIOUS PERMITS / APPLICATION NORMALLY REQUIRED TO COMPLETE A CONSTRUCTION PROJECT, SUCH AS, BUT NOT LIMITED TO:
 - ENTRANCE PERMIT
 - ROAD CLOSURE/SIDEWALK CLOSURE PERMIT
 - BUILDING PERMITS
 - ENCROACHMENT / LICENSE AGREEMENTS
 - SEWER & WATER CONNECTION APPLICATIONS
- A DETAILED LOT GRADING PLAN IS TO BE SUBMITTED TO THE CITY OF THUNDER BAY AS PART OF THE BUILDING PERMIT APPLICATION BASED ON THE ACTUAL PROPOSED BUILDING ENVELOPE.
- TYPICAL SWALE TO BE SHOWN WHERE NEEDED TO CONTAIN DRAINAGE WITHIN OWN PROPERTY. DIRECT DRAINAGE AWAY FROM ADJACENT PROPERTIES AND OUT TO STREET OR LANEWAY.

BENCHMARK

- ELEVATIONS SHOWN HEREON ARE GEODETIC REFERRED TO BENCHMARK LOCATED AT <INSERT BENCHMARK LOCATION & DESCRIPTION>
ELEV: 123.45m
WHERE A GEODETIC BENCHMARK IS NOT AVAILABLE, A FIXED OBJECT, SUCH AS THE TOP OPERATING NUT ON A FIRE HYDRANT CAN BE USED.

SAMPLE SEVERANCE LOT GRADING & DRAINAGE PLAN

(title block is available in CAD upon request)

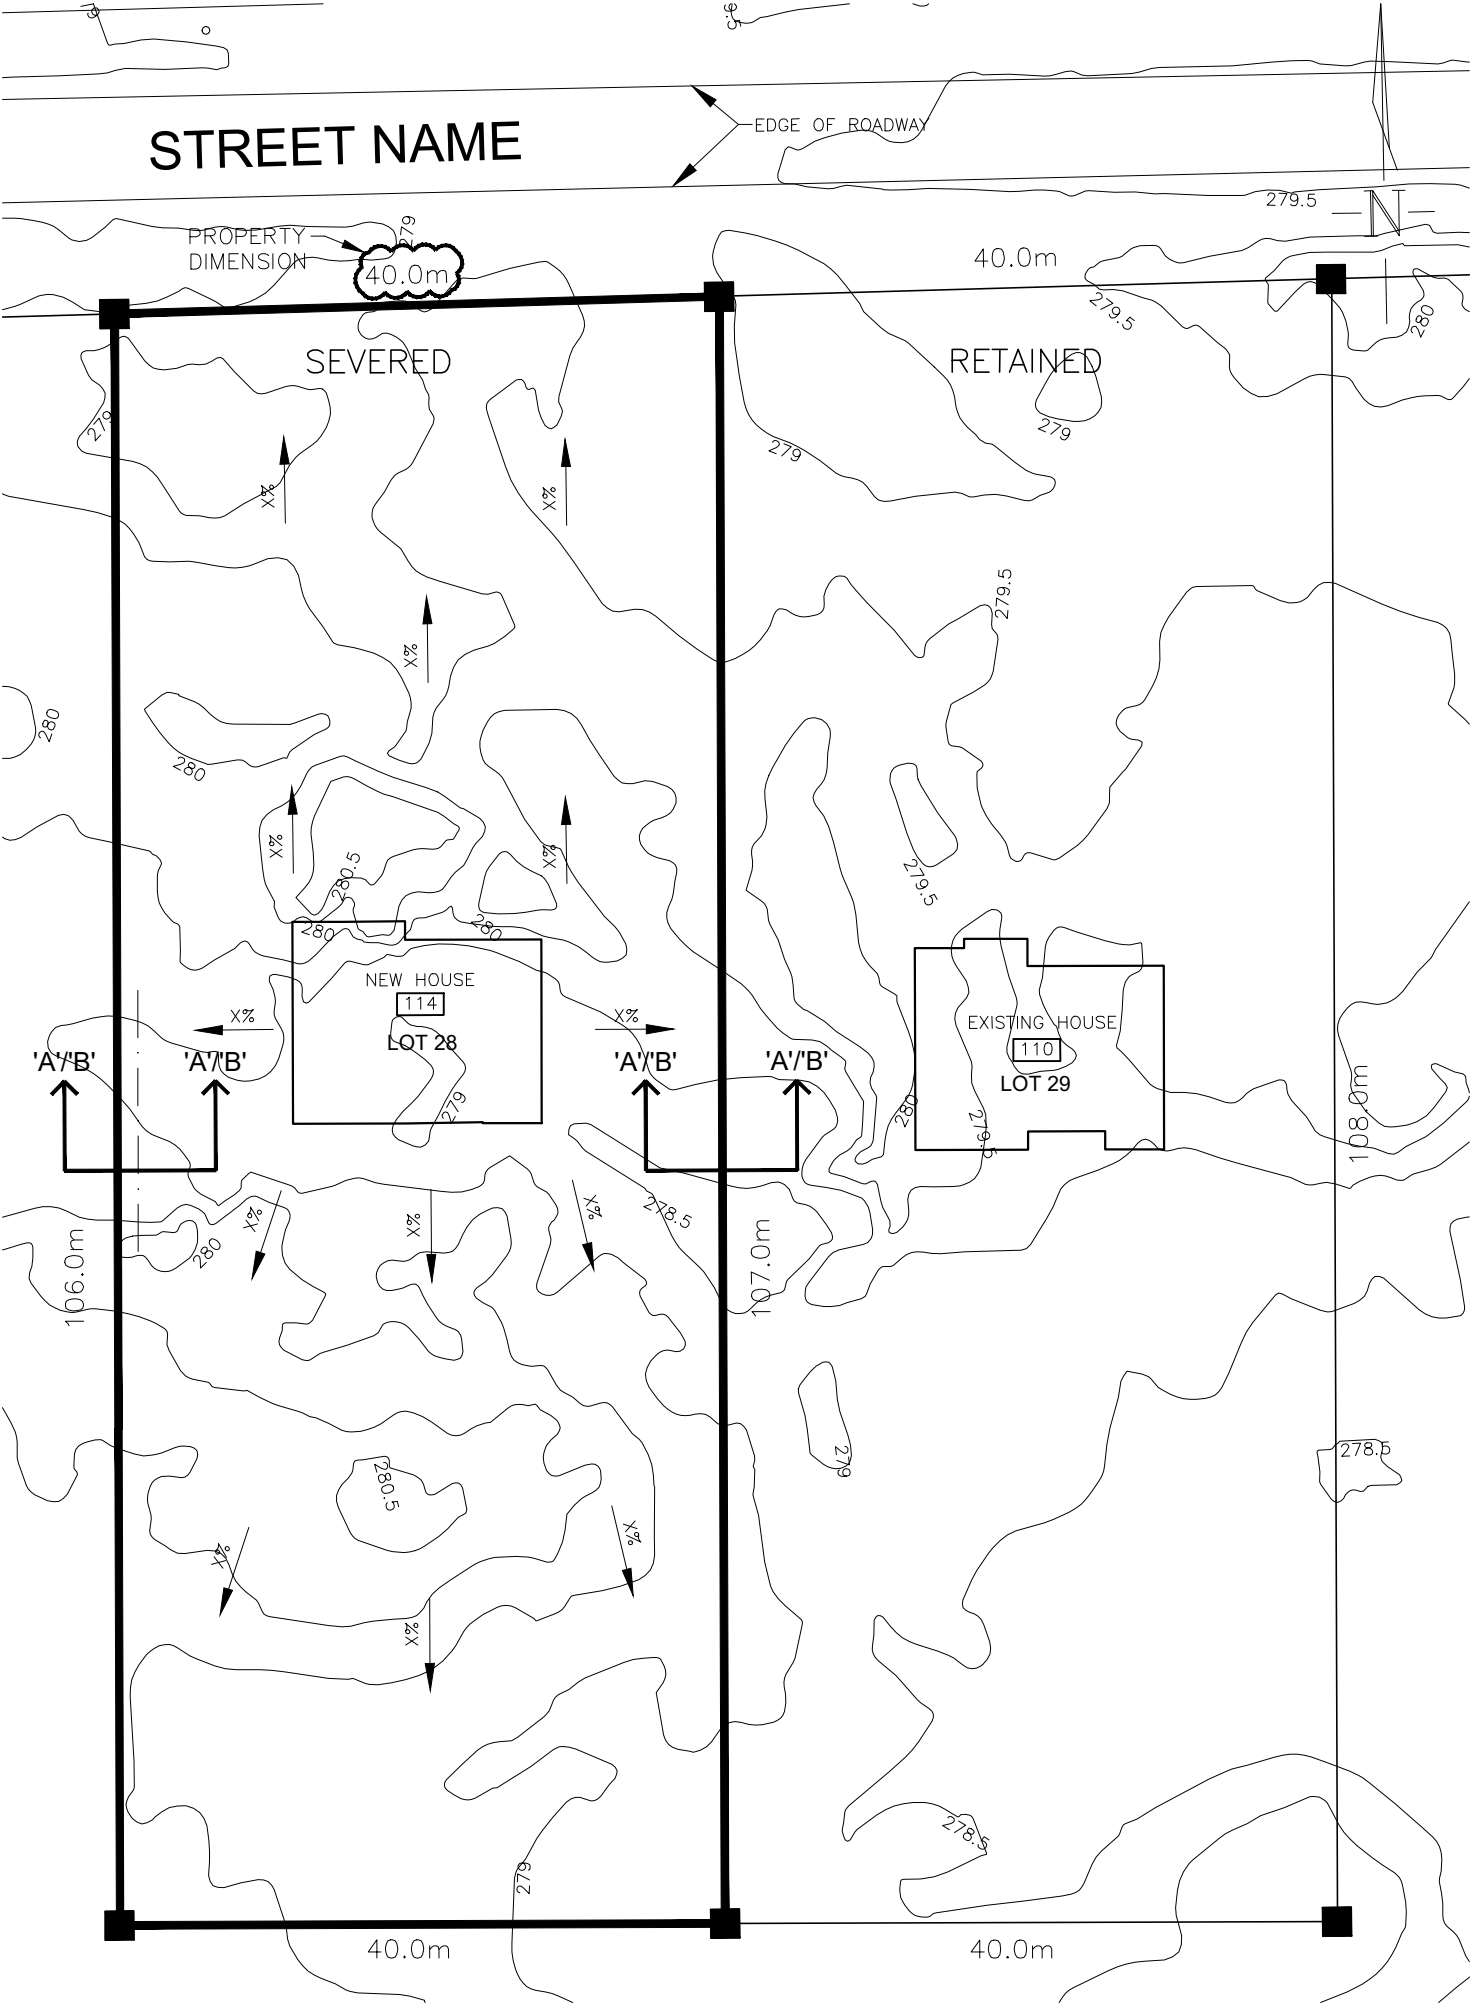

THE PROPOSED LOT GRADING IS IN
GENERAL CONFORMITY WITH THE CITY
OF THUNDER BAY SEVERANCE LOT
GRADING GUIDELINES.

COMPANY NAME: _____

GRADING PLAN
PREPARED BY: _____

SIGNATURE: _____

DATE: _____


TO BE SIGNED BY
PLAN DESIGNER

3.			
2.			
1.	FIRST SUBMISSION	02/22/25	AW
NO.	REVISIONS	DATE	INITIAL


LOT GRADING PLAN FOR
<SEVERANCE B-X-XXXX>

SCALE: 1:500
DATE: 02/22/25
DRAWN: AW
DESIGNED: AW

DWG. NO.
SP1

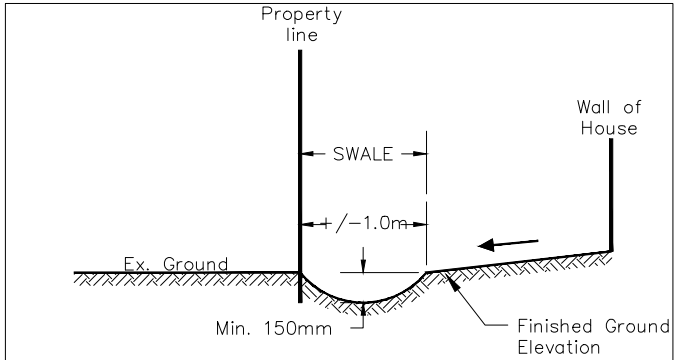

SAMPLE SWALE DETAIL 'A'

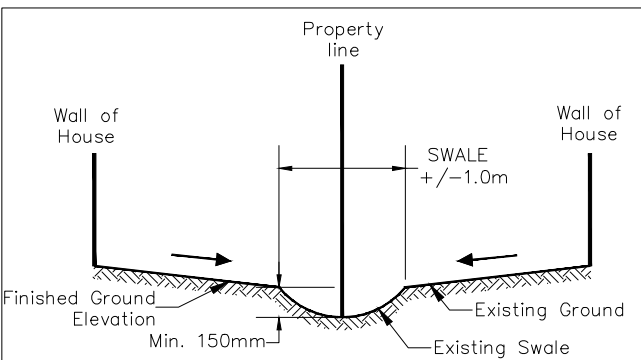

SAMPLE SWALE DETAIL 'B'

SEVERANCE LOT GRADING PLAN CHECKLIST

SEVERANCE LOT GRADING PLAN REQUIREMENTS		COMPLETED			
		Y	N	N/A	Comment
Drainage	Existing elevations on the road and / or laneway, ditch, boulevard, curb and subject lot				
	Location of buildings, existing and / or proposed, including those on adjacent lands.				
	Proposed elevations at all building corners, swales & changes in grade				
	Direction of drainage and surface slope (1.0% min. lot slope - Eng. Std. 2.3.5.k, 5% preferred max, 10% max)				
	Average rear yard slope not to exceed 10% (Eng. Std. 2.3.5.j)				
	Swale depth (0.1m min, 0.20-0.25m preferred, - Eng. Std. 2.3.5.l)				
	Drainage flows around building in defined swale (i.e. back-to-front lots - Eng. Std. 2.3.5.m)				
	Maximum grading slope of 2H:1V (3H:1V preferred) - Eng. Std. 2.3.5.k				
	Retaining wall details and elevations				
	Roof leader & splash pad locations (to be directed to front - Eng. Std. 2.3.5.o & 2.3.3)				
	Dry well location to be shown where a sump pump discharge to a storm sewer is not provided (min. 5m from building per OBC)				
Cross-Section(s) showing how grading matches into adjacent properties, or typical swale cross-sections provided & labelled					
Structure	Outline of building(s), garage(s), driveway(s) shown (show approx. building envelope)				
Zoning	Building Setbacks Shown and Labeled				
	Zoning Designation Box Shown (Building Division will review contents)				
External Info	Has a Entrance Permit be applied for?				
	Boulevard information: edge of pavement or roadway, street lights, transformers, pedestals, poles, hydrants, trees etc. shown?				
Legal	Municipal Address				
	Easements and/or reserves				
	Lot Dimensions				
Misc.	Metric Scale				
	Geodetic or temporary benchmark description and elevation				
	North arrow, and date / revision box				
	Required General Notes (see #1 to 6 on sample lot grading & drainage plan)				

Note: Existing contour maps are available from Mapping Services. Please contact: buildtbay@thunderbay.ca 807-622-8453